

EXTERIOR LUMINAIRE SCHEDULE



CALLOUT	SYMBOL	LAMP	DESCRIPTION	MODEL	INPUT WATTS	VOLTS	QUANTITY
OFX1	•	(1) 69W LED	EXTERIOR WALL PACK	LITHONIA CSKW LED 30C 700 50K T3M MVOLT OR APPROVED EQUAL INSTALLED AT 20' - 0" A.F.F.	69	120V 1P 2W	20
OFX2	•	(1) 209W LED	EXTERIOR POLE MOUNT	LITHONIA CSX1 LED 60C 1000 50K T3M MVOLT HS OR APPROVED EQUAL POLE MOUNTED AT 20' - 0" A.F.F.	209	120V 1P 2W	10

CALL-OUT NOTES

- ALL OUTDOOR LIGHTING TO BE CONNECTED VIA AUTOMATIC TIME SWITCH IN CONJUNCTION WITH PHOTOCELL. ALL OUTDOOR LIGHTING TO ALSO BE CONNECTED VIA DIMMABLE CONTROLLER IN CONJUNCTION WITH MOTION SENSOR THAT HAS AUTO-ON FUNCTIONALITY THAT AUTOMATICALLY REDUCES LIGHTING POWER BETWEEN 40-80 PERCENT PER 1-24 REQUIREMENTS (TYP). (S)(P)(D)(M)
- CONTRACTOR TO VERIFY THAT PROPER SHIELDING AND CUT-OFF IS IN PLACE TO PREVENT LIGHT SPILL ONTO NEIGHBORING PROPERTY AS WELL AS LIGHT GLARE (TYP).
- POLE BASE DETAIL TO BE PROVIDED BY OTHERS TO STRUCTURALLY MEET WIND AND SOIL CONDITIONS. (TYP)
- CONTRACTOR TO INSTALL WALL MOUNT LIGHT FIXTURES AT 20' A.F.F.

LIGHTING CONTROL LEGEND

- (S) AUTOMATIC TIME SWITCH
- (P) DIMMER SWITCH (LOW OR LINE VOLTAGE)
- (D) PHOTOCELL SENSOR
- (M) MOTION SENSOR
- (M) DEMAND RESPONSIVE SIGNAL

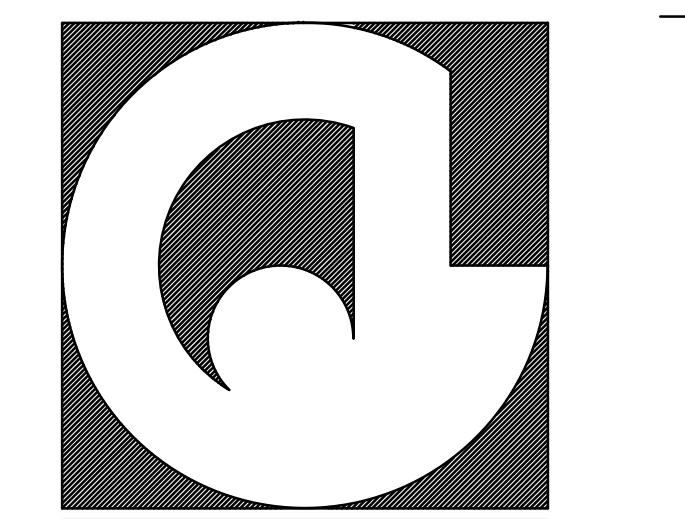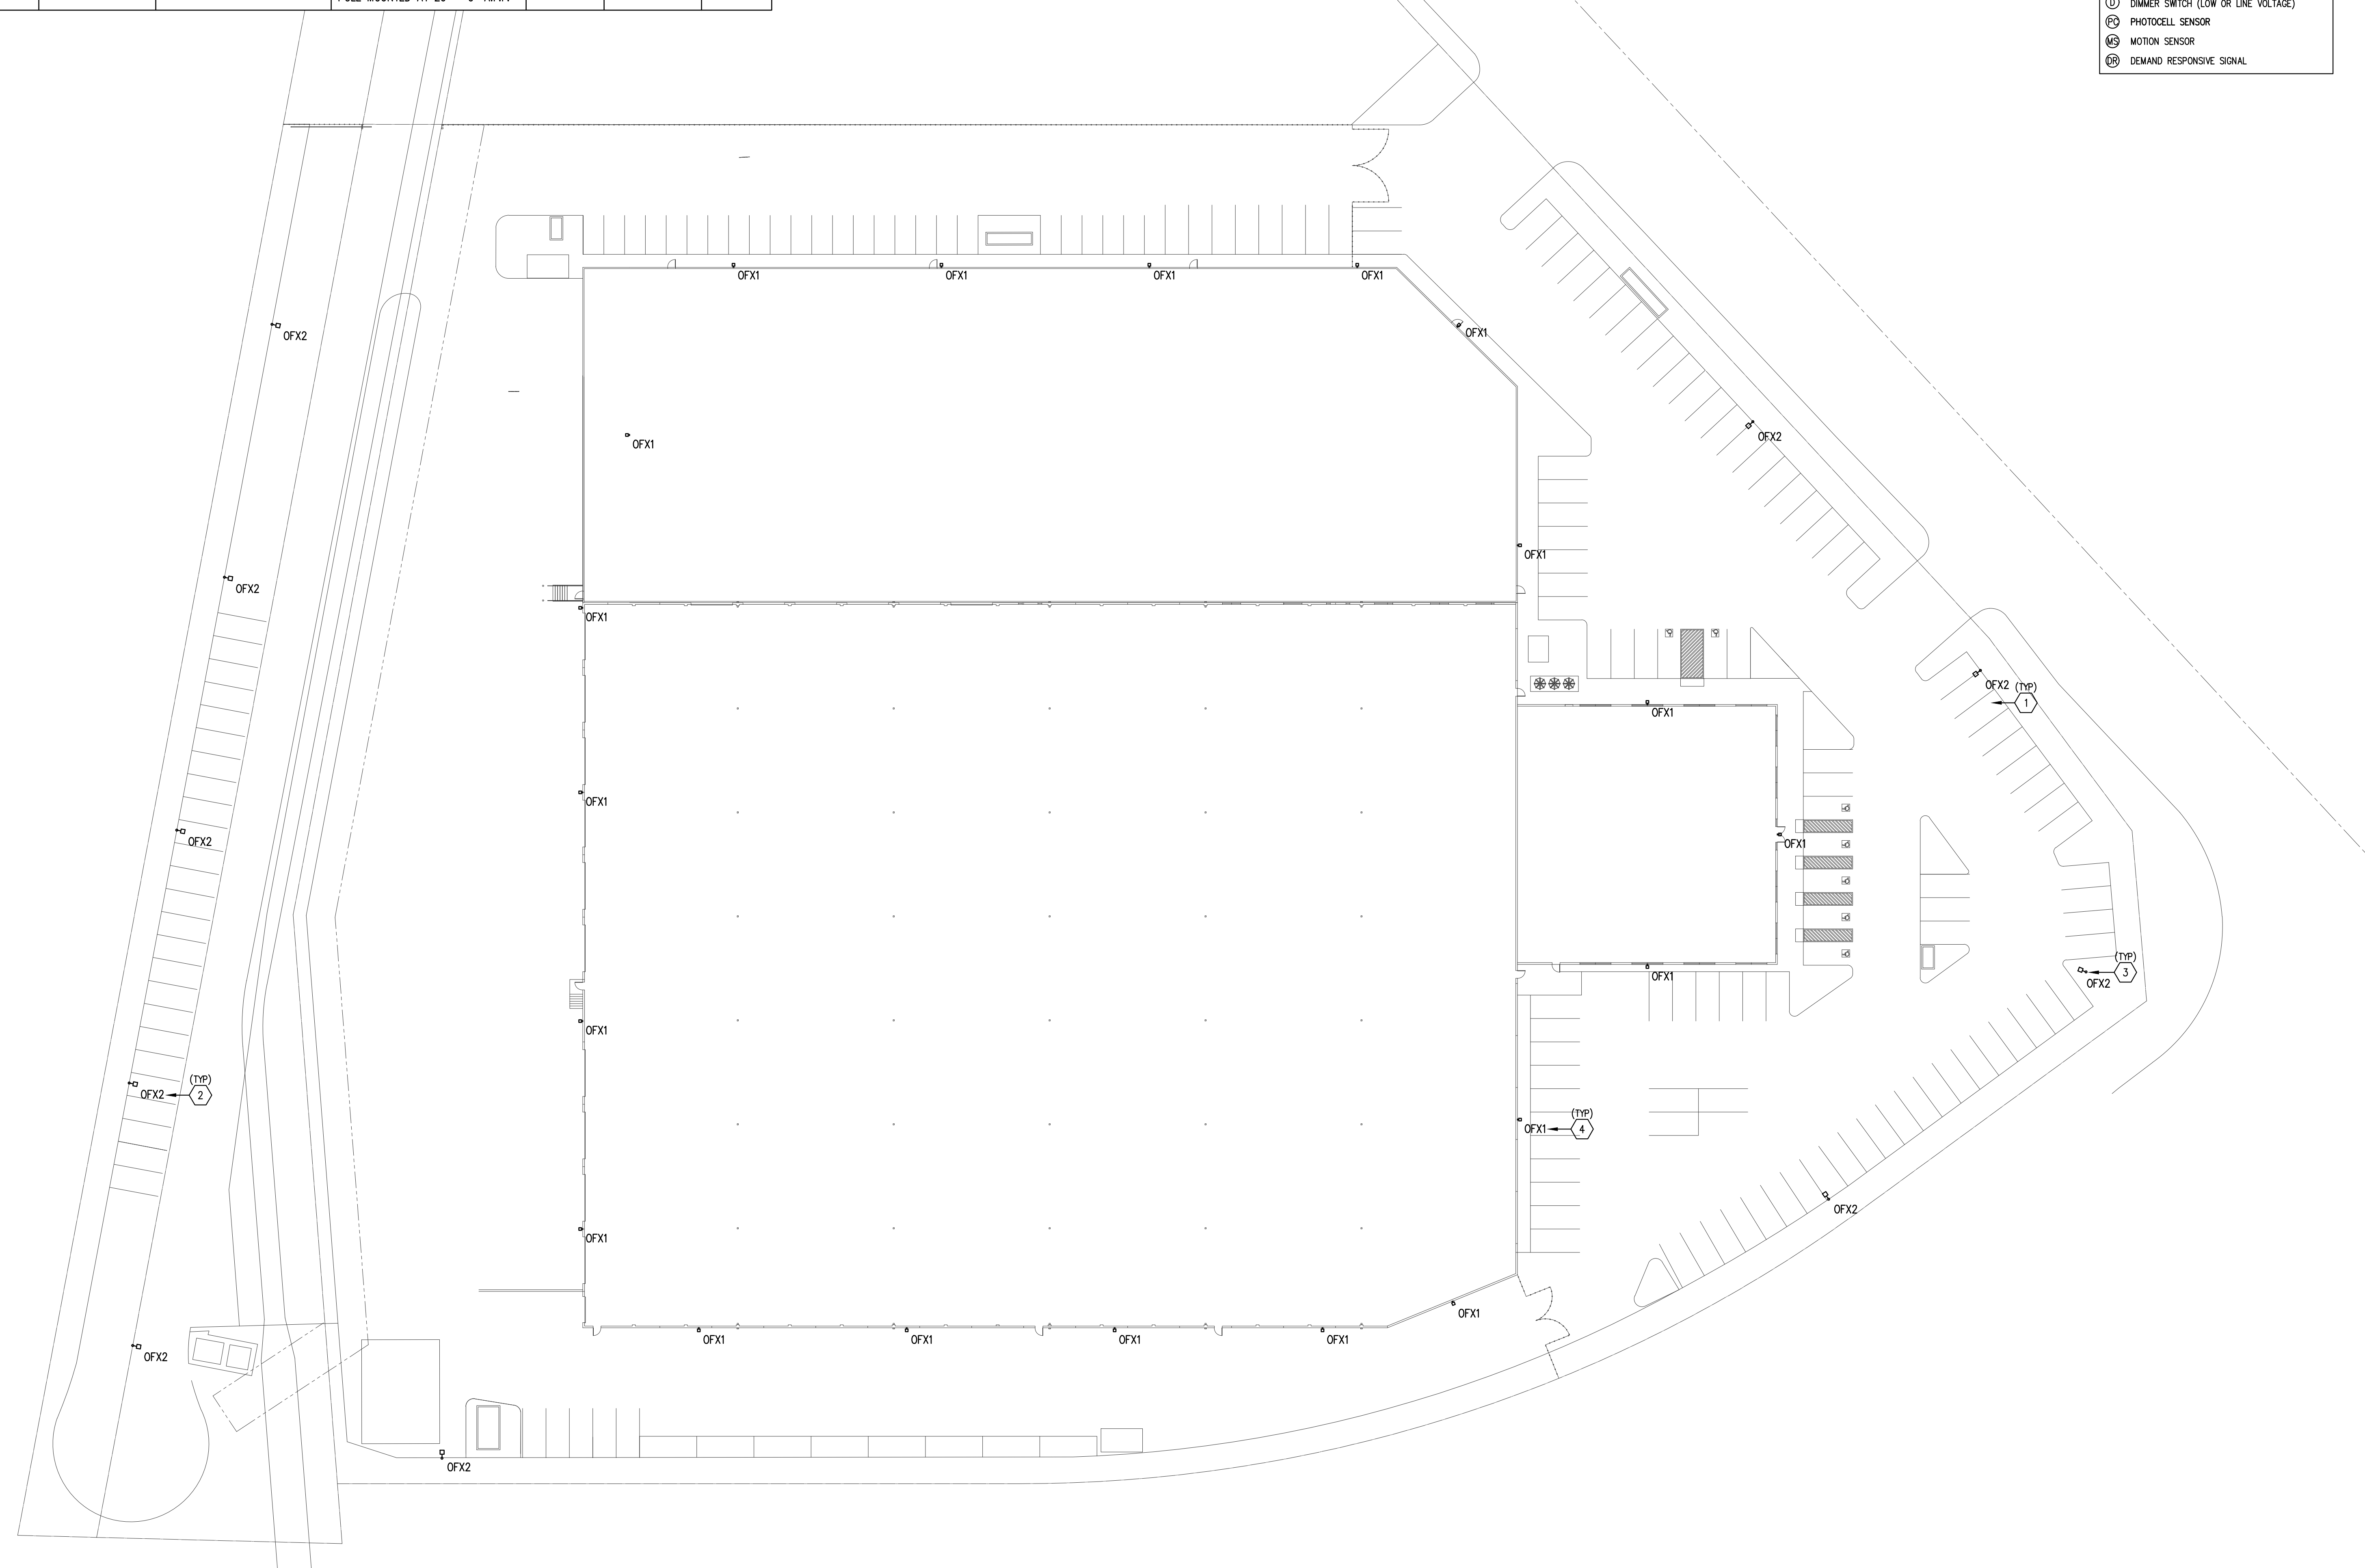

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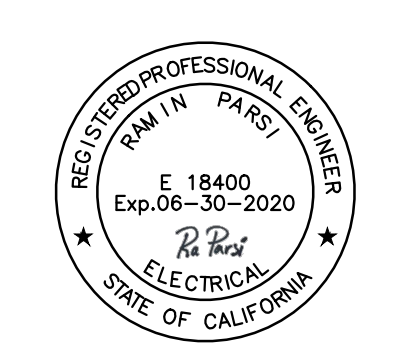
PROJECT NAME & SITE ADDRESS:

NEW BUILDING
12821 KNOTT ST.
GARDEN GROVE, CA 92841

DEVELOPER :

JOHN G. CATALDO
A.I.A. C.S.I.

Drawing Content :
SITE PLAN, LIGHTING



Revisions :

PLAN CHECK - 05/08/19
REVISIONS - 10/18/19

Designer : M.J.
Manager : M.J.
Date : 10/18/2019
Job No : 2018-202
Scale : 1/30"=1'-0"


Drawing No :

SITE PLAN, LIGHTING

SCALE: 1/30"=1'-0"

E1.0


SHEET : OF : PR-1

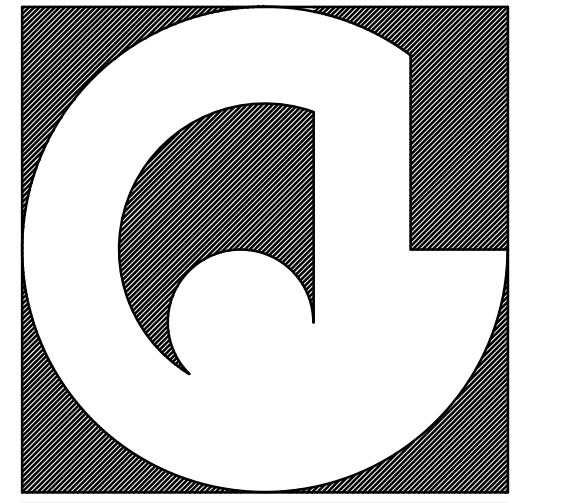


JOHN G. CATALDO A.I.A. C.S.T.

**GENERAL
PHOTOMETRIC
SCHEDULE**

AVERAGE FOOT-CANDLES	1.18
MAXIMUM FOOT-CANDLES	4.8
MINIMUM FOOT-CANDLES	.0

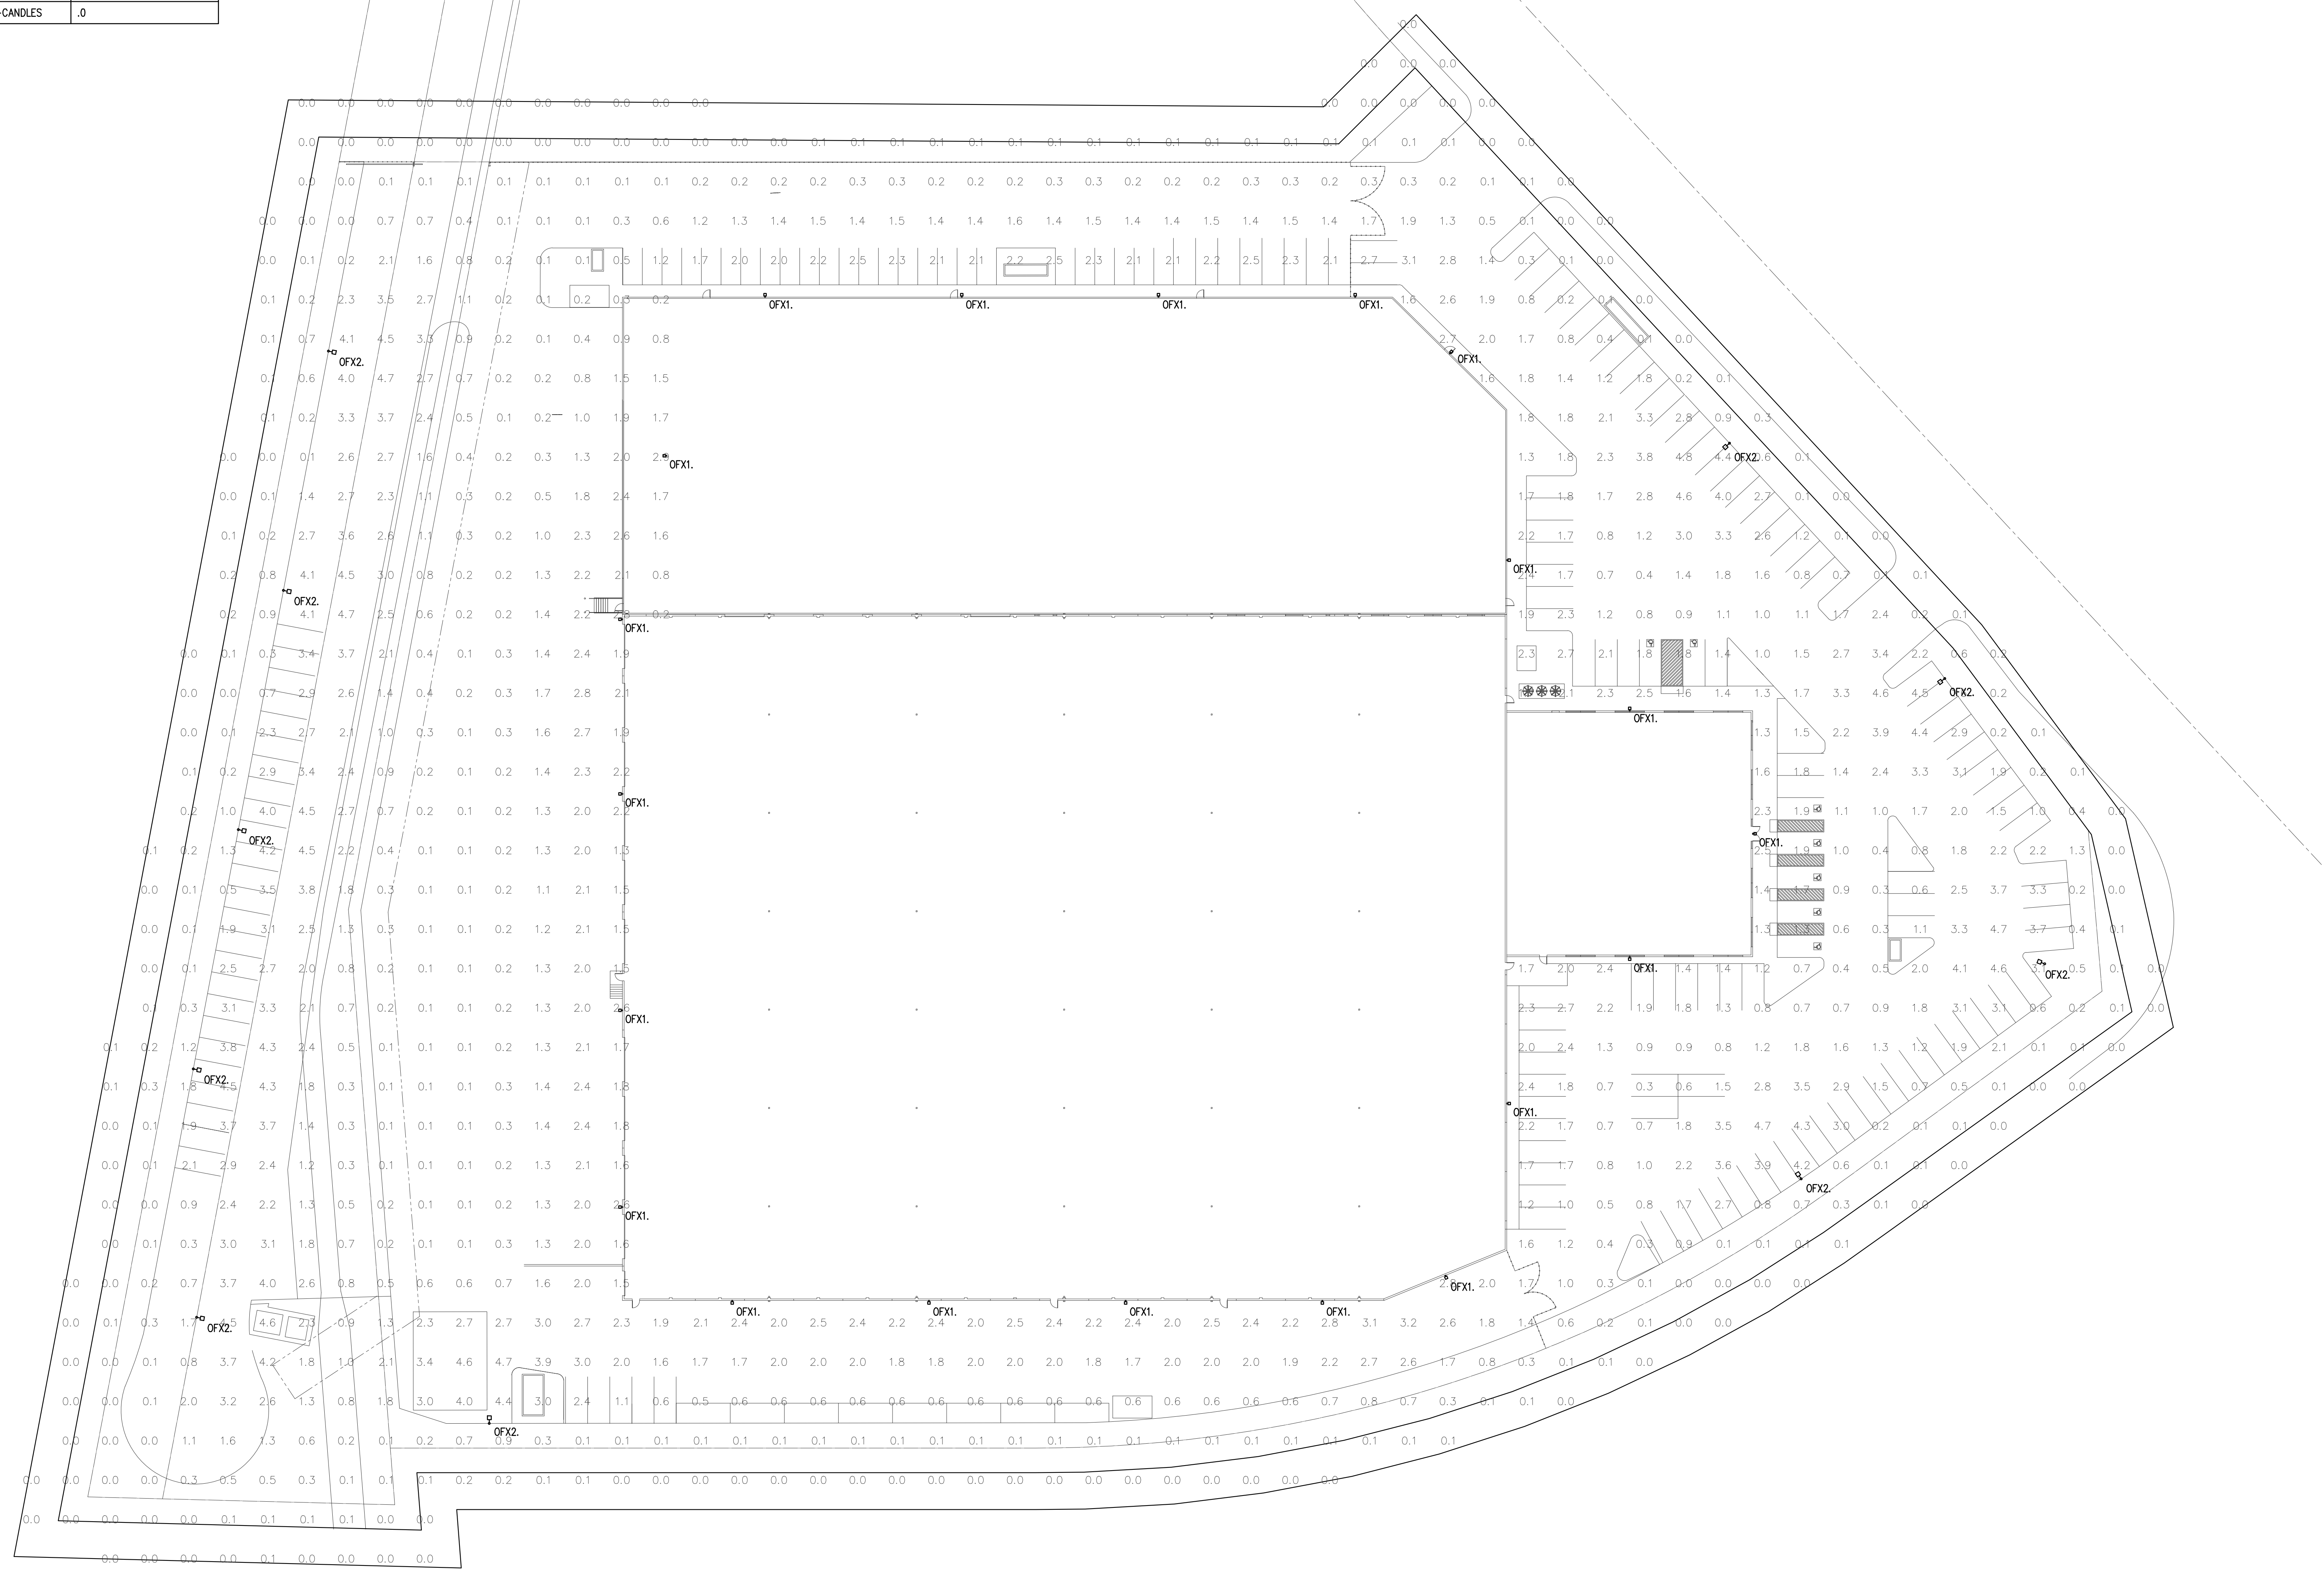

Drawing Content :
SITE PLAN, PHOTOMETRICS

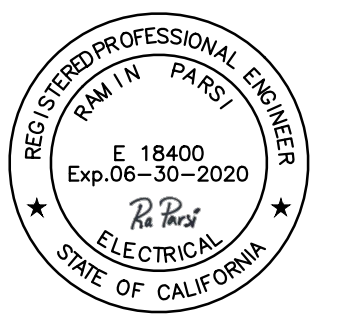

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Drawing No :

SITE PLAN, PHOTOMETRICS

SCALE: 1/30"=1'-0"

E2.0